#### PROJECT INFO: LANDSCAPE NOTES: I. ALL LANDSCAPE AND IRRIGATION SHALL CONFORM TO THE COUNTY OF SAN OWNER: DIEGO LANDSCAPE STANDARDS MANUAL AND ALL OTHER APPLICABLE BRETT FEUERSTEIN STANDARDS AS OF THE APPROVED DATE OF THESE PLANS. MIRA MESA SHOPPING CENTER 2. TREES PLANTED WITHIN 10 FEET OF WALKS, CURBS OR PAVING SHALL BE 8294 MIRA MESA BLVD. PLANTED WITH A ROOT BARRIER (BIO-BARRIER, 19.5" DEPTH) SAN DEIGO, CA 92126 3. ALL PLANTING AREAS SHALL BE FINISHED WITH A 3 INCH LAYER OF SHREDDED BARK MULCH (ECOBARK) AVAILABLE THROUGH BUTLERS MILL, INC. (619) 858-271-4682 263-6181. PROVIDE SAMPLE TO LANDSCAPE ARCHITECT FOR APPROVAL 4. ALL LANDSCAPE MATERIALS SHALL BE PERMANENTLY MAINTAINED IN A COMPOSTING GROWING AND HEALTHY CONDITION AT ALL TIMES, INCLUDING TRIMMING AS LANDSCAPE ARCHITECT: APPROPRIATE TO MAINTAIN APPROVED LANDSCAPE MATERIALS. ANY REQUIRED PLANT MATERIAL THAT DIES POS-CONSTUCTION SHALL BE JPBLA, INC. REPLACED AT SIZES AND QUANTITIES SET FORTH UNDER 142.0403(B)(8) 4403 MANCHESTER AVE, STE 201 5. IN THE EVENT THE ROADS ARE WIDENED, THE EXISTING STREET TREES SHALL BE ENCINITAS,CA 92024 RELOCATED TO THE SATIFACTION OF THE COUNTY OF SAN DIEGO'S 760-479-0644 DEVELOPMENT SERVICES. 6. NO BRUSH MANAGEMENT SHALL BE BE REQUIRED FOR THIS PROJECT. ARCHITECT: PROJECT NOTES: ZAAP, INC 2900 FOURTH ST. #204 GENERAL: SAN DIEGO, CA 92103 - REFER TO ARCHITECTURAL SITE PLAN IS FOR BUILDING 619-233-6450 IDENTIFICATION AND INFORMATION ONLY. - IN THE EVENT OF A CONFLICT BETWEEN LANDSCAPE ENGINEER: PLANS AND ARCHITECTURAL PLANS, LANDSCAPE PLANS BME SHALL TAKE PRECEDENCE FOR SITE DRAINAGE 0 9449 BALBOA AVENUE, #270 - ALL LANDSCAPE AND IRRIGATION SHALL CONFORM TO San Diego, CA 92123 THE STANDARDS OF THE COUNTY-WIDE LANDSCAPE 619-299-5550 REGULATIONS AND THE COUNTY OF SAN DIEGO LANDSCAPE DEVELOPMENT MANUAL LANDSCAPE STANDARDS AND ALL OTHER LANDSCAPE RELATED COUNTY AND REGIONAL STANDARDS. SHEET INDEX: PHASE 'A' PLANTING: - A MINIMUM OF 3" OF TOP DRESS MULCH WILL BE APPLIED CD1.0 - BLDG D GRADING PLAN N 174'26' W 192 LC-I TITLE SHEET TO ALL EXPOSED SOIL SURFACE EXCLUDING TURF CD2.0 - SEWER PLIAN CONCEPTUAL PLANTING PLAN "DUNKIN" LC-2 AREAS. LC-3 CONCEPTUAL WATER CALCULATION PLAN - SPACING OF SLOPE SHRUBS AND GROUND COVERS ADEQUATE FOR EROSION CONTROL. REFER TO PLANTING LEGEND. REINFORCED STRAW MATTING WILL BE INSTALLED ON ALL SLOPES 3:1 OR - ALL EXISTING TREES SHOWN ON PLAN ARE OFF-SITE. DD'S DISCOUNT 21,000 SF TARGET SPACE 46.644 SF LANDSCAPE ARCHITECT NEW **Smart&Final** OBSERVATION REQUIREMENTS SUB-TENANT O'REILLY THE LANDSCAPE PROJECT WILL REQUIRE THE FOLLOWING 27,992 S.F. AUTO SUBMITTALS BE PROVIDED TO THE LANDSCAPE **PARTS** ARCHITECT FOR REVIEW: A) ALL PRODUCT SUBMITTALS 8,561 S.F. FOR CONFORMANCE WITH APPROVED PLANS. LANDSCAPE ARCHITECT SHALL BE CONTACTED TO OBSERVE AND REVIEW THE IRRIGATION MAIN LINE PRESSURE TEST. PHASE 'C' LANDSCAPE ARCHITECT SHALL BE CONTACTED TO CF1.0 - BLDG F GRADING PLAN OBSERVE THE IRRIGATION COVERAGE TEST LANDSCAPE ARCHITECT OF WORK: CF2.0 - BLDG F CIVIL ENLARGED 4. LANDSCAPE ARCHITECT SHALL BE CONTACTED TO HEREBY DECLARE THAT I AM THE LANDSCAPE ARCHITECT OF OBSERVE THE PLANT MATERIAL INSPECTION ON-SITE WORK FOR THIS PROJECT, THAT I HAVE EXERCISED RESPONSIBLE UPON DELIVERY, AND VERIFY PLANT LOCATIONS IN CHARGE OVER THE DESIGN OF THE PROJECT AS DEFINED IN F3.0 - BLDG F CML DETAILS SECTION 6703 OF THE BUSINESS AND PROFESSIONS CODE, AND THAT THE DESIGN IS CONSISTENT WITH CURRENT STANDARDS. AND TREE REMOVAL PLAN 5. LANDSCAPE ARCHITECT SHALL BE CONTACTED TO OBSERVE THE INSTALLATION IS IN SUBSTANTIAL CF4.0 - BLDG F UTILITY PLAN CONFORMANCE WITH THE APPROVED PLANS. JAMES P. BENEDETTI, R.L.A. #3058 PREPARE AN AS-BUILT PLAN OF ANY CHANGES AND MY REGISTRATION EXPIRES 09/30/22 PROVIDE THE OWNER A COPY OF THE IRRIGATION 4403 MANCHESTER AVE. SUITE 201 DEPICTING AS-BUILT LOCATIONS OF THE MAINLINE AND ENCINITAS, CA 92024 REMOTE-CONTROL VALVES BY DIMENSIONS FROM KNOWN 760-479-0644 SITE ELEMENTS. LANDSCAPE CONTRACTOR SHALL FOLLOW APPROVED PLANS AM FAMILIAR WITH THE REQUIREMENTS FOR LANDSCAPE AND FOR CONSTRUCTION. ANY DEVIATIONS FROM APPROVED IRRIGATION PLANS CONTAINED IN THE COUNTY LANDSCAPE S 174'26"E 150' PLANS SHALL BE SUBMITTED TO THE LANDSCAPE ARCHITECT WATER CONSERVATION REGULATIONS, IN TITLE 8, DIVISION 6, OF RECORD FOR REVIEW AND APPROVED PRIOR TO CHAPTER 7, OF THE SAN DIEGO COUNTY CODE OF REGULATORY CONSTRUCTION ORDINANCES. I HAVE PREPARED THIS PLAN IN COMPLIANCE WITH THOSE REGULATIONS. I CERTIFY THAT THE PLAN IMPLEMENTS THOSE REGULATIONS, TO PROVIDE EFFICIENT USE OF WATER. 9/30/20 JAMES/F. BENEDETTI, R.L.A. #3058 DATE MY REGISTRATION EXPIRES 09/30/22 PHASE 'B' 4403 MANCHESTER AVE. SUITE 201 CG1.0 - BLDG GRADING PLAN ENCINITAS, CA 92024 760-479-0644 CG2.0 - BLDG G STORMWATER DETAILS , JAMES P BENEDETTI, CERTIFY THAT THE LANDSCAPE AND IRRIGATION PLAN AS SHOWN HEREON PER THIS GRADING PLAN SATISFY THE GRADING ORDINANCE REQUIREMENTS AS STATED PER SECTION 87.417 (PLANTING) AND SECTION 87.418 (IRRIGATION). I AM FAMILIAR WITH THE REQUIREMENTS FOR GRADING DESIGN PLANS CONTAINED IN THE COUNTY LANDSCAPE WATER CONSERVATION REGULATIONS, IN TITLE 8, DIVISION 6, CHAPTER 7 OF THE SAN DIEGO COUNTY CODE OF REGULATORY ORDINANCES. I HAVE PREPARED THIS PLAN IN COMPLIANCE WITH THOSE REGULATIONS. I CERTIFY THAT THE PLAN IMPLEMENTS THOSE **VICINITY MAP** REGULATIONS TO PROVIDE EFFICIENT USE OF WATER. 9/30/22 JAMES P. BENEDETTI, R.L.A. #3058 MY REGISTRATION EXPIRES 09/30/22 4403 MANCHESTER AVE. SUITE 201 ENCINITAS, CA 92024 760-479-0644 SWEETWATER ROAD LANDSCAPE AREA FOR TOTAL COMMUNITY PLAN: SPRING VALLEY Spring Valley, CA 91977 NEW PROPOSED IMPROVEMENTS. GENERAL PLAN REGIONAL CATEGORY: VILLAGE PROJECT NO: 16350 CHICK-FIL-A 5845111700 (NOT A PART REVISION #: DATE: REVISION #: DATE: LOCATION SITE PLAN - PROPOSED 1" = 40'-0"PROJECT NAME: SHOPPING CENTER - SPRING VALLEY


S.E.C. JAMACHA RD. & SWEETWATER RD. SPRING VALLEY, CA


SAN DIEGO, CA 92103 619-233-6450 WWW.ZAAP.BIZ


2900 FOURTH AVENUE #204

SHOPPING CENTER -

**SPRING VALLEY** SHEET TITLE: LANDSCAPE CONCEPT PLAN

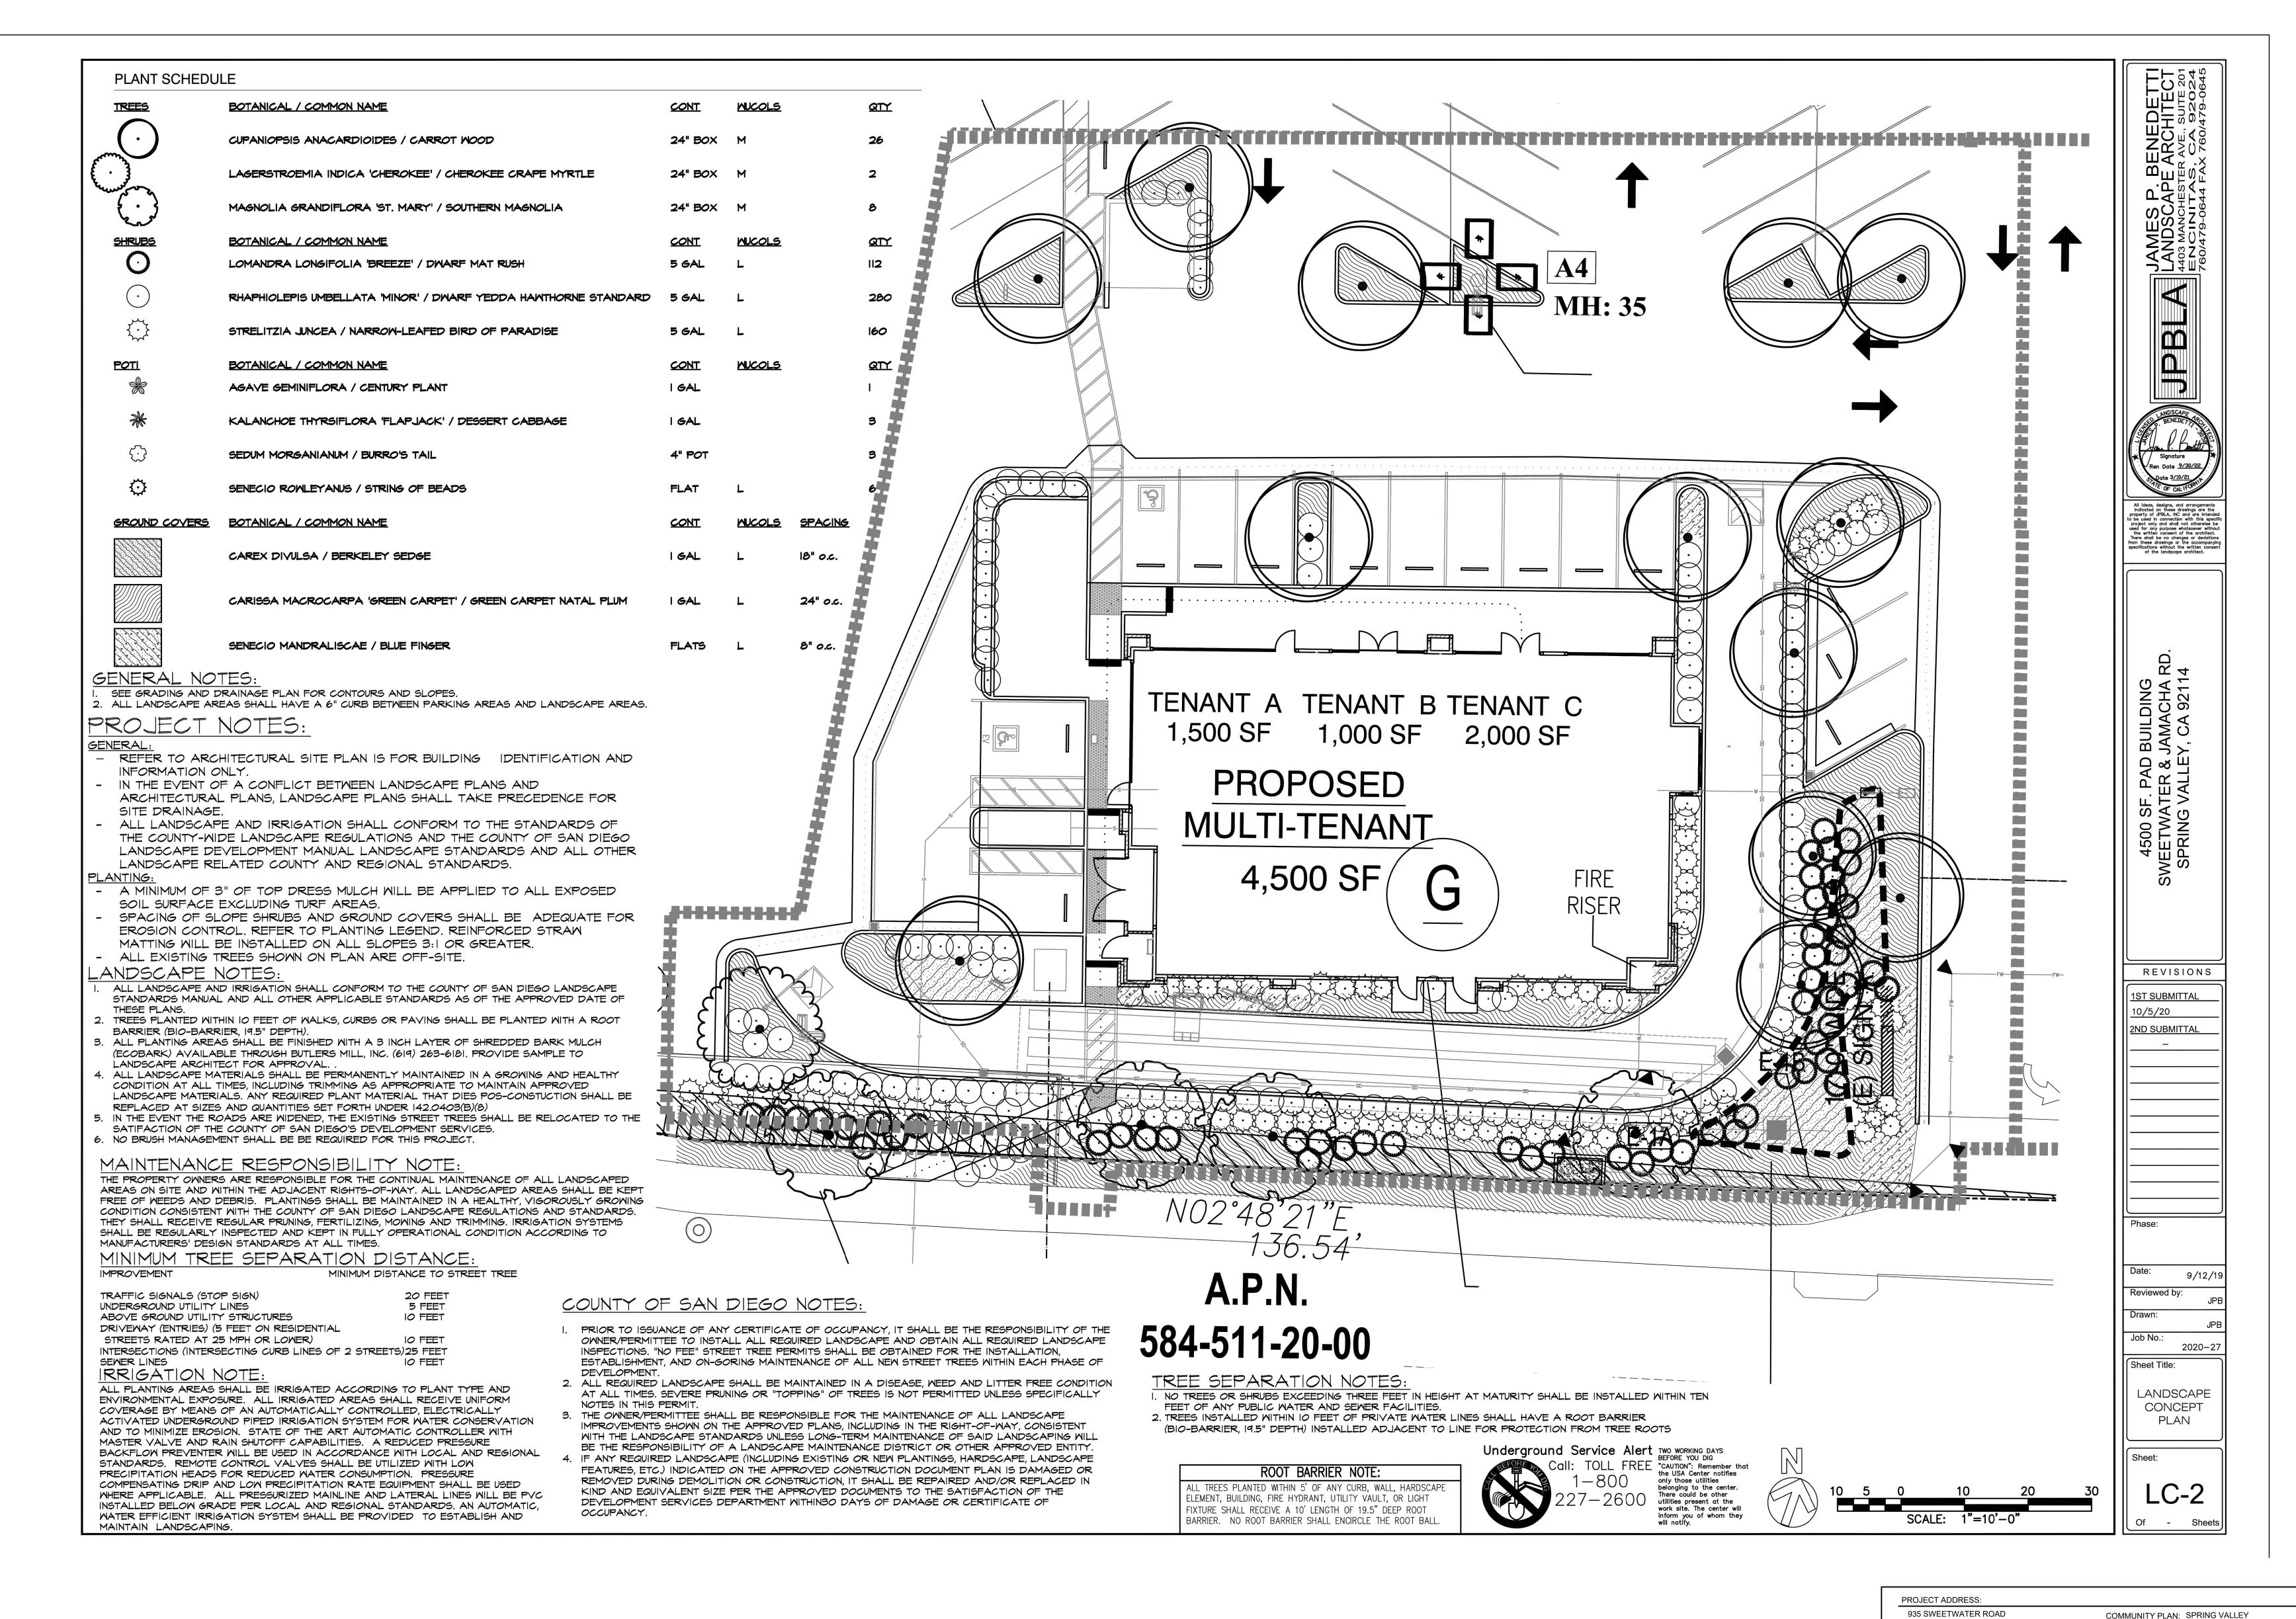

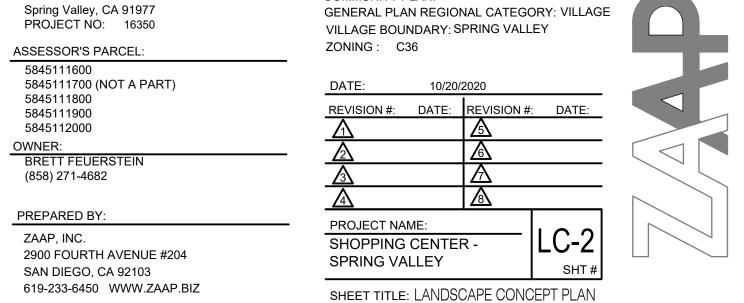

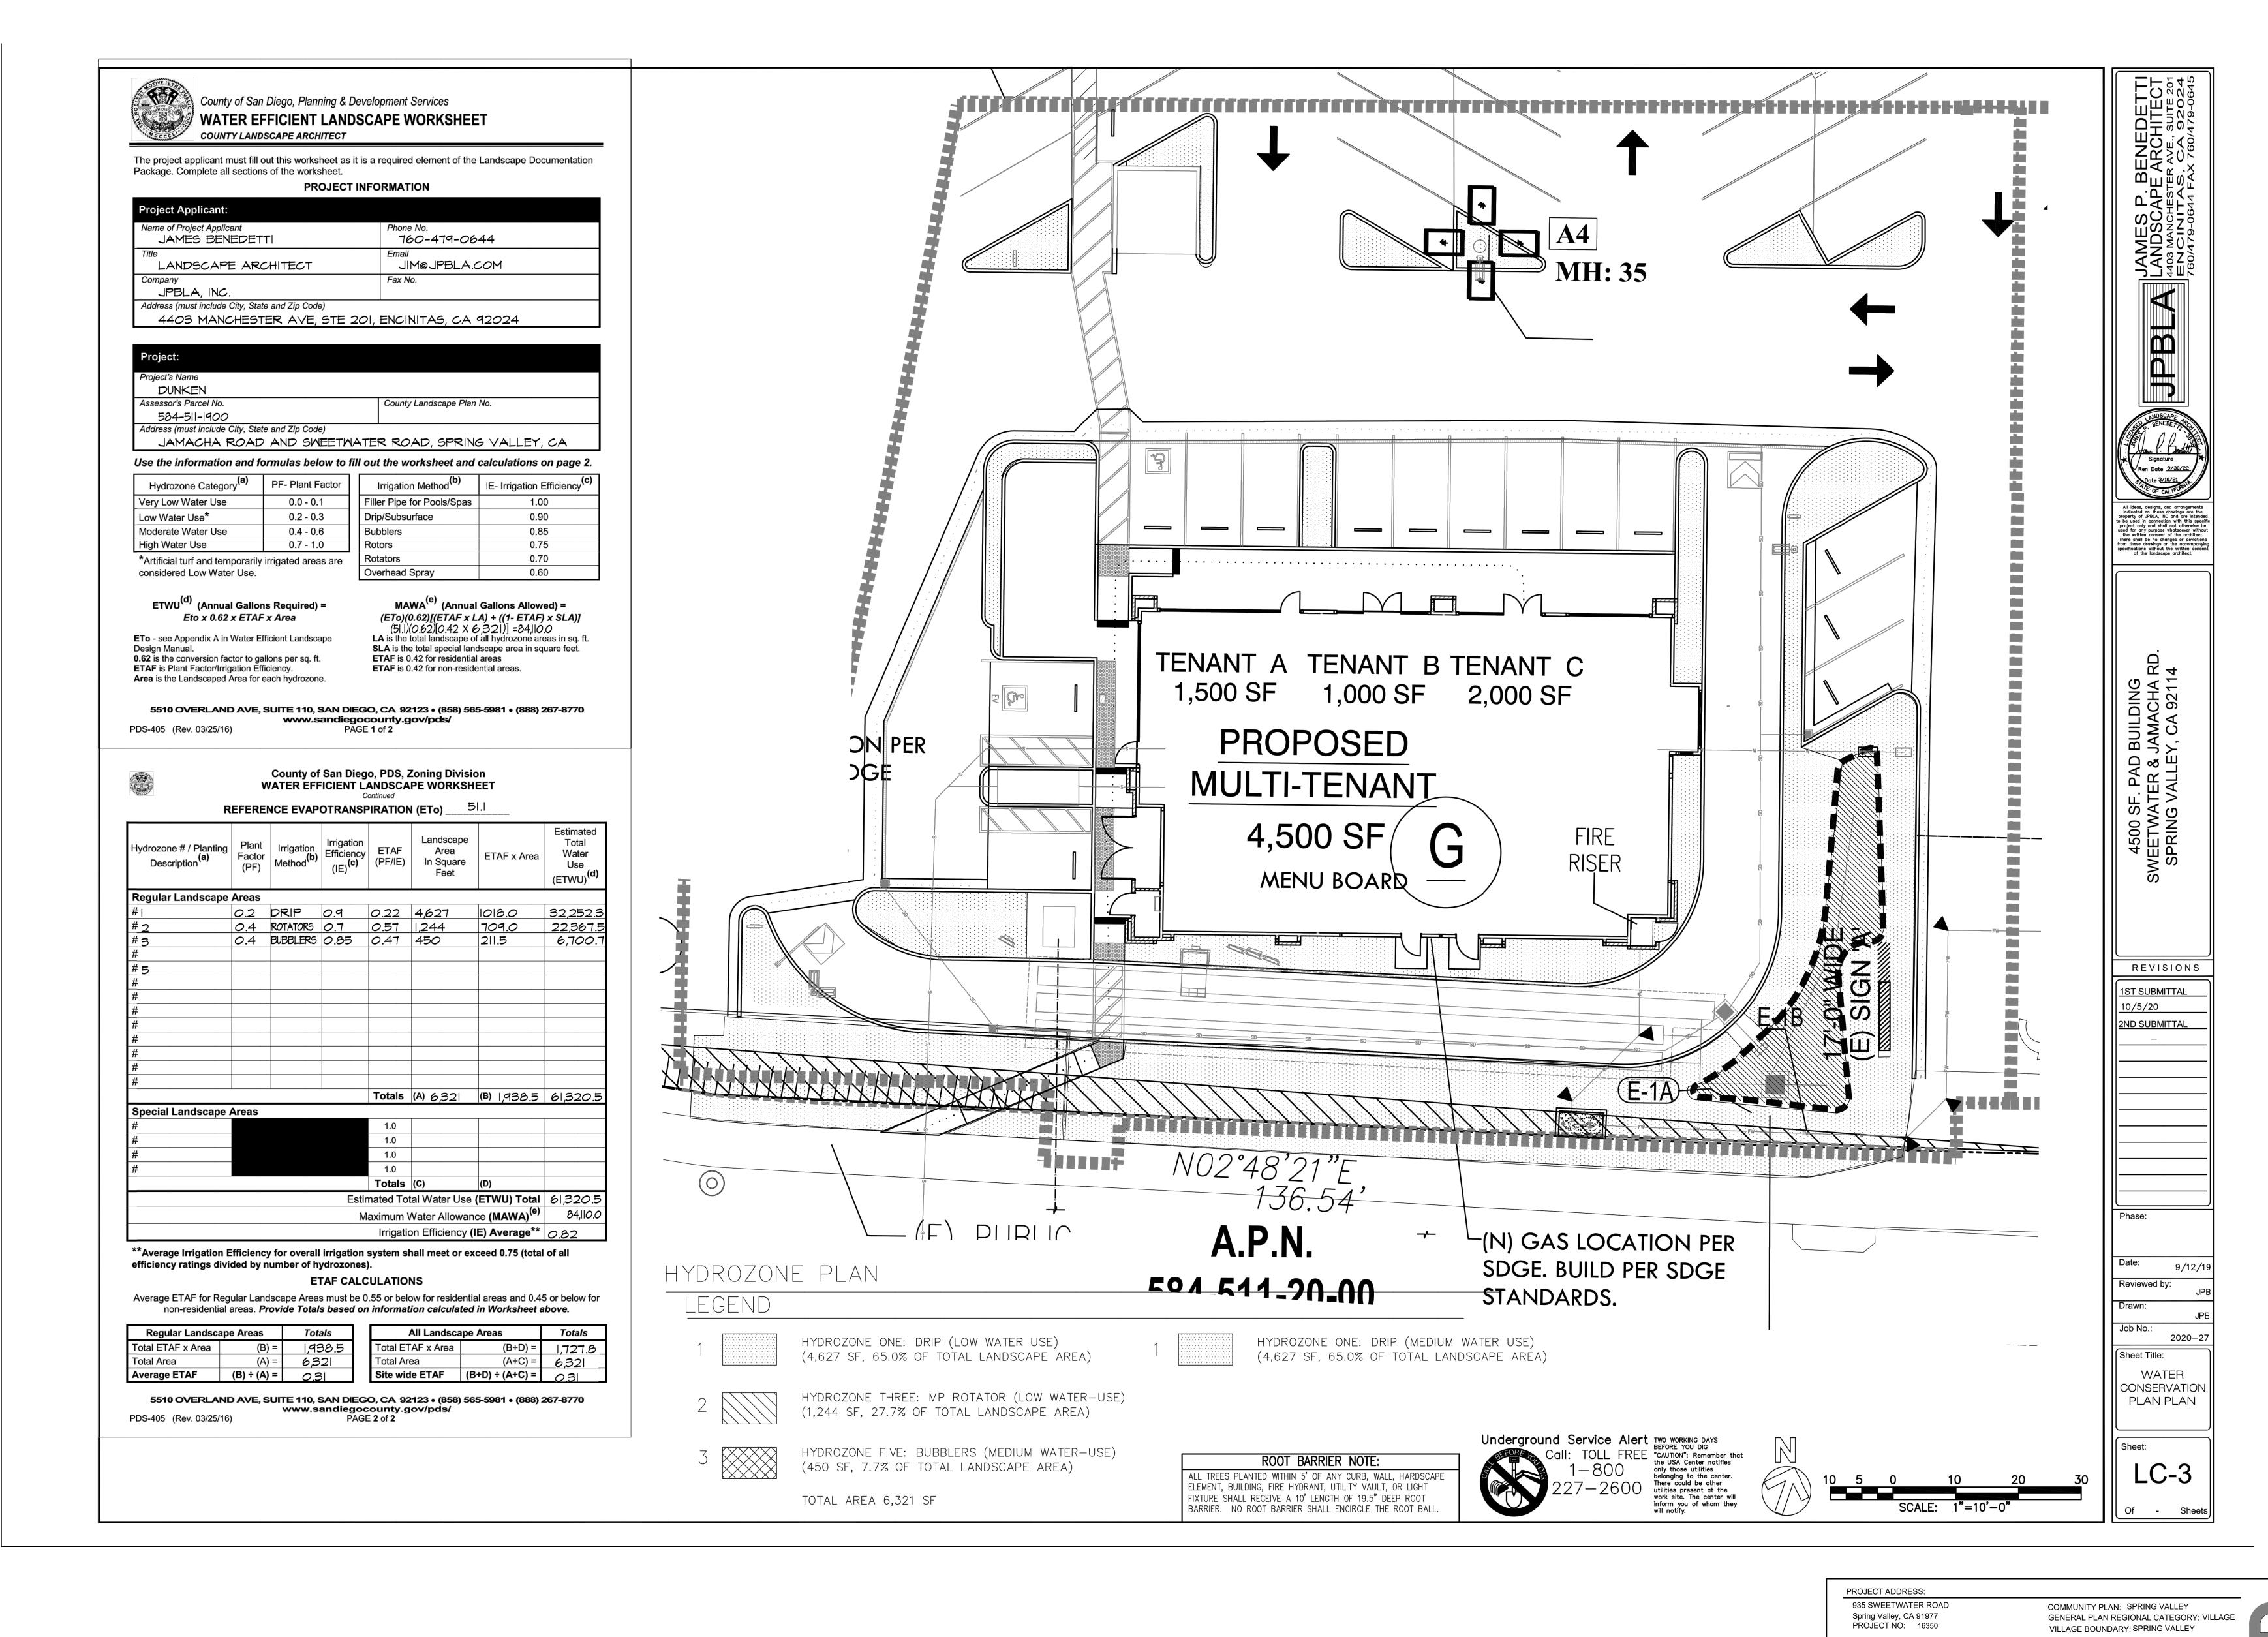

SHOPPING CENTER - SPRING VALLEY

PREPARED BY:

ZAAP, INC.
2900 FOURTH AVENUE #204
SAN DIEGO, CA 92103

ASSESSOR'S PARCEL

5845111800

5845112000

5845111700 (NOT A PART)

619-233-6450 WWW.ZAAP.BIZ

ZONING: C36

DATE: 10/20/2020

REVISION #: DATE: REVISION #: DATE:


\$\frac{1}{2}\$

\$\frac{1}{6}\$

\$\frac{1}{2}\$

PROJECT NAME:
SHOPPING CENTER SPRING VALLEY

SHEET TITLE: LANDSCAPE CONCEPT PLAN

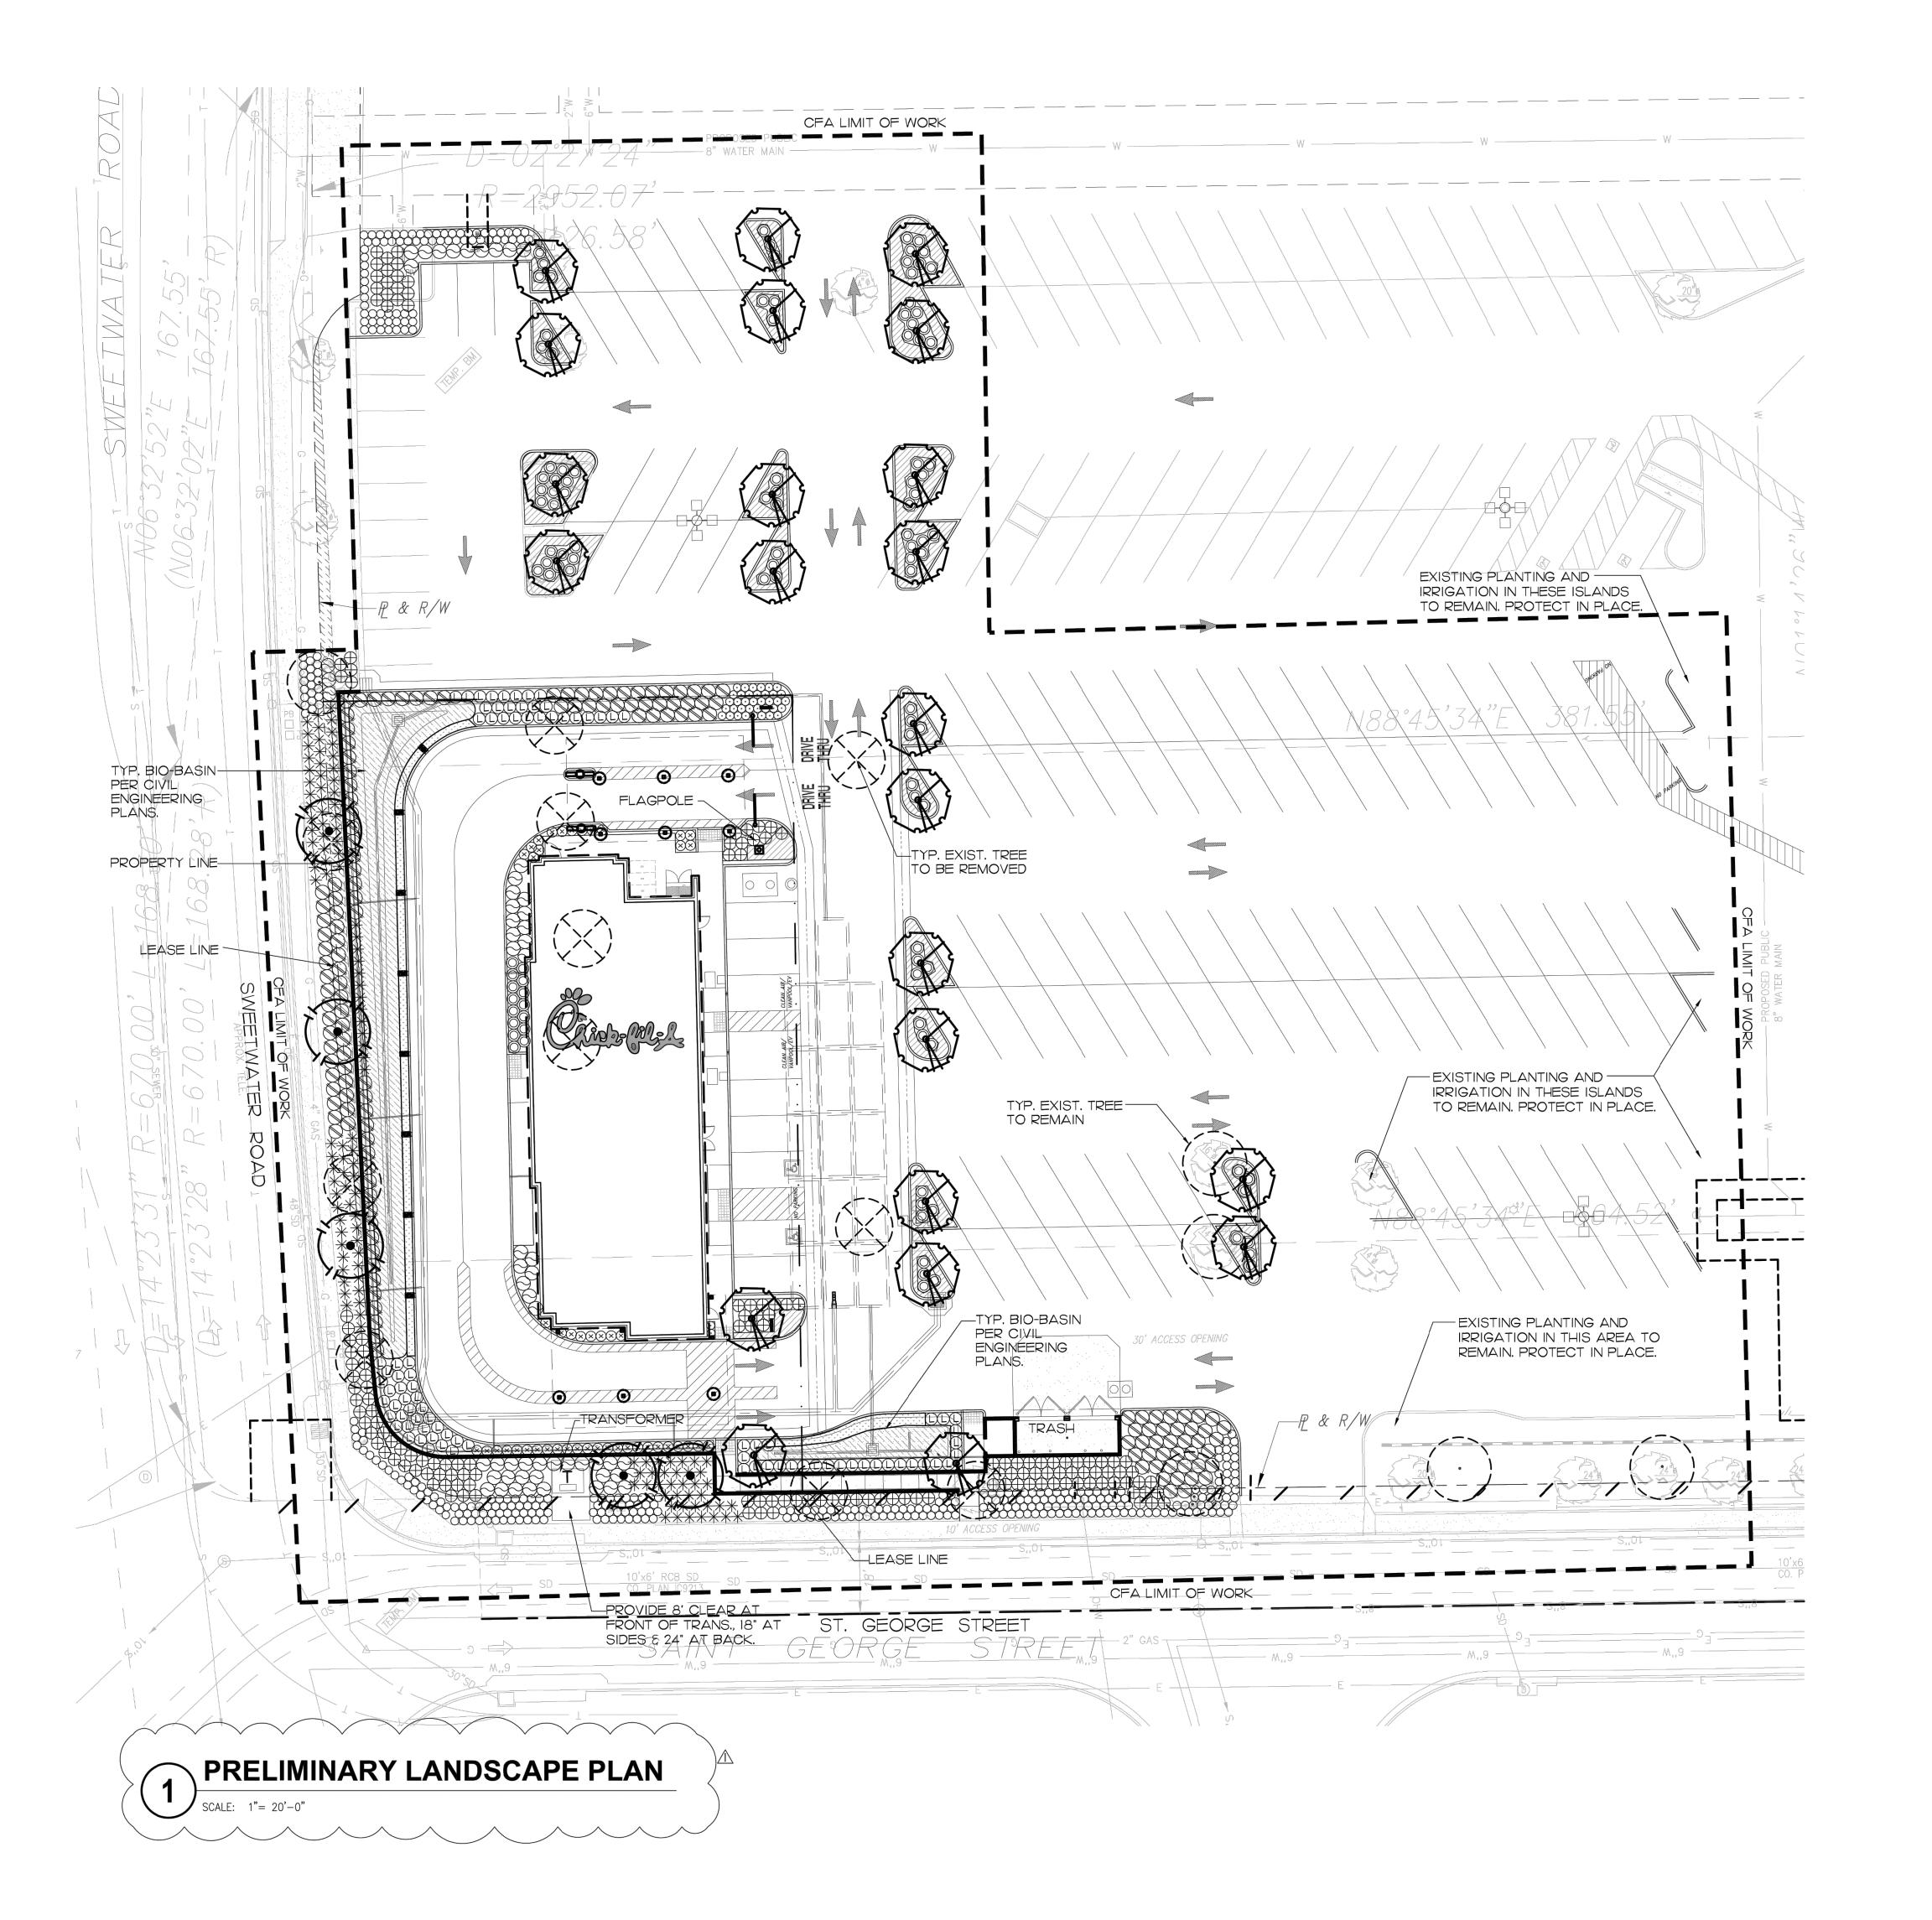



SYMBOL	BOTANICAL NAME	COMMON NAME	SIZE		JCOLS GION :	•
TREES				<u>150</u>	<u> </u>	<u> </u>
A STATE	LAGERSTROEMIA INDICA X FAUERI 'ARAPAHO'	CRAPE MYRTLE	24" BOX	23	М	STANDARD
	MAGNOLIA GRANDIFLORA 'ST. MARY'	SOUTHERN MAGNOLIA	24" BOX	5	М	STANDARD
$\bigcirc$	EXIST. TREES TO REMAIN - (	6				
	EXIST. TREES TO BE REMOV	/ED - II				
SHRUBS/GRO	<u>DUNDCOVERS</u>					
0	ALOE 'BLUE ELF'	BLUE ELF ALOE	1 GAL	370	L	2'-O" O.C.
	CALLISTEMON 'LITTLE JOHN'	DWARF BOTTLEBRUSH	5 GAL	114	L	3'-0" O.C.
	CAREX PANSA	MEADOW SEDGE	5 GAL	440 S.F.	L	l'-O" O.C.
	CHONDROPETALUM ELEPHANTINUM	LARGE CAPE RUSH	5 GAL	149	L	3'-6" O.C.
$\odot$	DIANELLA REVOLUTA 'BABY BLISS'	BLACK ANTHER	5 GAL	39	L	l'-6" O.C.
$\otimes$	DIANELLA X. 'CLARITY BLUE'	FLAX LILY	5 GAL	47	М	2'-6" O.C.
$\Theta$	LEUCADENDRON 'JESTER'	SUNSHINE CONEBUSH	5 GAL	58	L	3'-6" O.C.
	LEYMUS CONDENSATUS 'CANYON PRINCE'	WILD RYE	5 GAL	88	L	3'-O" O.C.
$\oplus$	LOMANDRA LONGIFOLIA BREEZE	DWARF MAT RUSH	5 GAL	154	L	3'-O" O.C.
*	MUHLENBERGIA CAPILLARIS	PINK MUHLY	5 GAL	126	L	3'-O" O.C.
	SENECIO SERPENS	BLUE CHALKSTICKS	I GAL	1,685 S.F.	L	2'-O" O.C.
BIO-E	BASIN PLANTING					
	DACINI DOTTOM & CIDEC 1.0		"	1015 05		

LANDSCAPE	CALCULATIONS
	O/1000/110110

12,908 S.F. CFA LANDSCAPE AREA: TURF AREA: TOTAL LANDSCAPE AREA: 12,908 S.F.

## PARKING LOT LANDSCAPING

PARKING SPACES PROVIDED -LANDSCAPING REQUIRED -(67 SPACES X 14 S.F. EA.) = 938 S.F. PARKING LOT LANDSCAPING PROVIDED - 2,033 S.F.

DMAS EXCLUDED FROM DCV CALCULATION

JUNCUS PATENS 'ELK BLUE'

SCIRPUS CERNUUS

SISYRINCHIUM BELLUM

SELF-MITIGATING DMAs

SELF-MITIGATING DMAs CONSIST OF NATURAL OR LANDSCAPED AREAS THAT DRAIN DIRECTLY OFFSITE OR TO THE PUBLIC STORM DRAIN SYSTEM. SELF-MITIGATING DMAS MUST MEET ALL OF THE FOLLOWING TO BE ELIGIBLE FOR EXCLUSION:

BASIN BOTTOM & SIDES - I GAL CONTAINER AT 2'-O" O.C. -

ELK BLUE GRAY RUSH

BLUE-EYED GRASS

LOW BULRUSH

VEGETATION IN THE NATURAL OR LANDSCAPED AREA IS NATIVE AND/OR NON-NATIVE/NON-INVASIVE DROUGHT TOLERANT SPECIES THAT DO NOT REQUIRE REGULAR APPLICATION OF FERTILIZERS AND PESTICIDES.

SOILS ARE UNDISTURBED NATIVE TOPSOIL, OR DISTURBED SOILS THAT HAVE BEEN AMENDED AND AERATED TO PROMOTE WATER RETENTION CHARACTERISTICS EQUIVALENT TO UNDISTURBED NATIVE TOPSOIL.

THE INCIDENTAL IMPERVIOUS AREAS ARE LESS THAN 5 PERCENT OF THE SELF-MITIGATING AREA.

IMPERVIOUS AREA WITHIN THE SELF-MITIGATED AREA SHOULD NOT B HYDRAULICALLY CONNECTED TO OTHER IMPERVIOUS AREAS UNLESS IT IS A STORM WATER CONVEYANCE SYSTEM (SUCH AS A BROW DITCH).


## PLANTING NOTES

- I. CONTRACTOR IS TO REVIEW PLANS, VERIFY SITE CONDITIONS AND 7. ALL LANDSCAPE AREAS SHALL BE FINISH GRADED TO PLANT QUANTITIES PRIOR TO INSTALLATION. CONFLICTS BETWEEN THE SITE AND THESE PLANS OR WITHIN THESE PLANS SHALL BE BROUGHT TO THE ATTENTION OF THE OWNER'S AUTHORIZED REPRESENTATIVE PRIOR TO LANDSCAPE INSTALLATION. ANY DEVIATION(S) FROM THE PLANS OR SPECIFICATIONS IS TO HAVE WRITTEN APPROVAL.
- 2. ALL PLANT MATERIAL SHALL BE IN ACCORDANCE WITH THE LATEST EDITION OF "AMERICAN NURSERY AND LANDSCAPE ASSOCIATION" STANDARDS. WWW.ANLA.ORG
- AREAS BY MEANS OF CONTINUOUS WATERING, PRUNING, RAISING TREE BALLS WHICH SETTLE BELOW GRADE, FERTILIZING, APPLICATION OF SPRAYS WHICH ARE NECESSARY TO KEEP THE PLANTINGS FREE OF INSECTS AND DISEASES, WEEDING, AND/OR OTHER OPERATIONS NECESSARY FOR PROPER CARE AND UPKEEP. THE LANDSCAPE CONTRACTOR SHALL MAINTAIN ALL PLANTINGS AS SPECIFIED ABOVE FOR A PERIOD OF NINETY (90) 4. LANDSCAPE ARCHITECT SHALL APPROVE PLANT MATERIAL

3. THE LANDSCAPE CONTRACTOR SHALL MAINTAIN ALL PLANTED

- PLACEMENT BY CONTRACTOR PRIOR TO INSTALLATION.
- 5. FERTILIZER FOR ALL PLANTING AREAS SHALL BE AS SPECIFIED WITHIN THE SOILS REPORT.
- 6. ANY TREES WITHIN 5' OF PAVING, CURBS, WALLS, BUILDINGS, ETC. TO BE INSTALLED WITH A ROOT BARRIER DEVICE.

- REMOVE ROCKS AND TO ENSURE SURFACE DRAINAGE AWAY FROM BUILDINGS.
- 8. CONTRACTOR TO INCLUDE IN HIS BID THE REPAIR OF ANY AND ALL DAMAGE RESULTING FROM INSTALLATION OF PLANTING ITEMS. CONNECT TO EXISTING CONDITIONS.
- 9. ALL PLANTING AND IRRIGATION ON THIS PROJECT TO MEET OR EXCEED COUNTY OF SAN DIEGO, CA LANDSCAPE GUIDELINES, STANDARDS AND AGENCY REQUIREMENTS.
- IO. ALL PLANTER AREAS SHALL BE TOP DRESSED WITH 3" MINIMUM MULCH COVER PER PLANS AND SPECIFICATIONS AS APPROVED BY THE LANDSCAPE
- II. ALL LANDSCAPE AREAS SHALL BE FINISH GRADED TO REMOVE ROCKS AND TO ENSURE SURFACE DRAINAGE AWAY FROM BUILDINGS.
- 12. ALL PLANTING AND IRRIGATION ON THIS PROJECT SHALL BE MAINTAINED BY THE PRIVATE OWNER/CHICK-FIL-A.

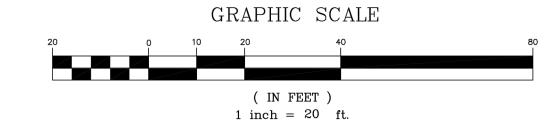

5845111800

5845111900

5845112000

(858) 271-4682


PREPARED BY:

2900 FOURTH AVENUE #204

619-233-6450 WWW.ZAAP.BIZ

SAN DIEGO, CA 92103

ZAAP, INC.

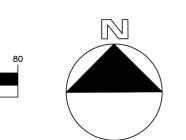







PROJECT ADDRESS: COMMUNITY PLAN: SPRING VALLEY GENERAL PLAN REGIONAL CATEGORY: VILLAGE VILLAGE BOUNDARY: SPRING VALLEY ZONING: C36

PROJECT NAME: SHOPPING CENTER -SPRING VALLEY

SHEET TITLE: LANDSCAPE CONCEPT PLAN



S.E.C. JAMACHA RD. & SWEETWATER RD.

SPRING VALLEY, CA

935 SWEETWATER ROAD Spring Valley, CA 91977 PROJECT NO: 16350 ASSESSOR'S PARCEL 5845111600 5845111700 (NOT A PART)

REVISION #: DATE: REVISION #: DATE:



County of San Diego, Planning & Development Services WATER EFFICIENT LANDSCAPE WORKSHEET

The project applicant must fill out this worksheet as it is a required element of the Landscape Documentation Package. Complete all sections of the worksheet.

#### PROJECT INFORMATION

Project Applicant:  Name of Project Applicant  XXX	Phone No.	
Title XXX	Email XXX	
Company XXX	Fax No. XXX	i i
Address (must include City, State and Zip Code)  XXX		

Project:	
Project's Name	
CHICKFIL-A RESTAURA	NT
Assessor's Parcel No.	County Landscape Plan No.
XXX	XXX

Hydrozone Category <sup>(a)</sup>	PF- Plant Factor	Irrigation Method <sup>(b)</sup>	IE- Irrigation Efficiency <sup>(c</sup>				
Very Low Water Use	0.0 - 0.1	Filler Pipe for Pools/Spas	1.00				
Low Water Use*	0.2 - 0.3	Drip/Subsurface	0.90				
Moderate Water Use	0.4 - 0.6	Bubblers	0.85				
High Water Use	0.7 - 1.0	Rotors	0.75				
*Artificial turf and temporarily	/ irrigated areas are	Rotators	0.70				
considered Low Water Use.	,,	Overhead Spray	0.60				

#### ETWU<sup>(d)</sup> (Annual Gallons Required) = Eto x 0.62 x ETAF x Area


ETo - see Appendix A in Water Efficient Landscape 0.62 is the conversion factor to gallons per sq. ft. ETAF is Plant Factor/Irrigation Efficiency.

Area is the Landscaped Area for each hydrozone.

#### MAWA<sup>(e)</sup> (Annual Gallons Allowed) = $(ETo)(0.62)[(ETAF \times LA) + ((1-ETAF) \times SLA)]$

LA is the total landscape of all hydrozone areas in sq. ft. **SLA** is the total special landscape area in square feet. ETAF is 0.55 for residential areas ETAF is 0.45 for non-residential areas.

### 5510 OVERLAND AVE, SUITE 110, SAN DIEGO, CA 92123 • (858) 565-5981 • (888) 267-8770 PDS-405 (Rev. 03/25/16)

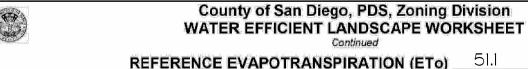

Hydrozone # / Planting Description <sup>(a)</sup>		Plant Factor (PF)	Irrigation Method <sup>(b)</sup>	Irrigation Efficiency (IE)	ETAF (PF/IE)	Landscape Area In Square Feet	ETAF x Area	Estimated Total Water Use (ETWU)
Re	gular Landscape	Areas						
#	SHRUBS	0.40	DRIP	0.90	0.44	12,683	5,636.9	178,588
#								
#	TREES	0.40	BUBB	0.85	0.47	225	105.9	3,355
#								
#								
					Totals	(A) 12,908	<b>(B)</b> 5,742.8	181,943
	ecial Landscape /	Areas						
#					1.0	0	0	
#					1.0			
#					1.0			
#					1.0			
						( <b>c</b> ) 12,908		
							(ETWU) Total	181,943
				Ma	aximum V	Vater Allowan	ce (MAWA) <sup>(e)</sup>	184,028
							E) Average**	0.875

\*\*Average Irrigation Efficiency for overall irrigation system shall meet or exceed 0.75 (total of all efficiency ratings divided by number of hydrozones).

## **ETAF CALCULATIONS**

Average ETAF for Regular Landscape Areas must be 0.55 or below for residential areas and 0.45 or below for non-residential areas. Provide Totals based on information calculated in Worksheet above.

5510 OVERLAND AVE, SUITE 110, SAN DIEGO, CA 92123 • (858) 565-5981 • (888) 267-8770 www.sandiegocounty.gov/pds/ PAGE 2 of 2

Regular Landsca	ipe Areas	Totals	All Landsc	ape Areas
Total ETAF x Area	(B) =	5,742.8	Total ETAF x Area	(B+D) =
Total Area	(A) =	12,908	Total Area	(A+C) =
verage ETAF	(B) ÷ (A) =	0.445	Site wide ETAF	(B+D) ÷ (A+C) =

PDS-405 (Rev. 03/25/16)

PRESSURE LOSS CALCULATIONS

VALVE A-4	13.0 GPM
WATER METER BACKFLOW PREVENTER MISCELLANEOUS MAINLINE (190 L.F.) LATERALS FITTINGS REMOTE CONTROL VALVE PRESSURE REQUIRED AT HEAD ELEVATION LOSS	1.00 11.00 5.00 1.20 4.00 0.60 2.70 30.00
TOTAL PRESSURE LOSS EXISTING STATIC WATER PRESSURE RESIDUAL WATER PRESSURE	58.20 75.00 16.80

#### MAINTENANCE MANUAL

2:00 AM AND 9:00 AM.

THIS MANUAL TO BE KEPT AT THE CONTROLLER LOCATION AT ALL TIMES. IRRIGATION SYSTEMS:

- I. AUTOMATIC CONTROLLER TO BE CHECKED MONTHLY BY LANDSCAPE MAINTENANCE FOREMAN AND CHECKED WEEKLY BY MAINTENANCE CREW LEADER, TO PROVIDE OPTIMUM PLANT GROWTH AND WATER CONSERVATION. (IF SMART CONTROLLER IS IN USE, CHECK ELECTRICAL
- 2. LANDSCAPE MAINTENANCE CONTRACTOR TO CHECK ALL SYSTEMS ONCE PER MONTH BY TURNING ON EACH SYSTEM MANUALLY.
- 3. LANDSCAPE MAINTENANCE CONTRACTOR TO VISUALLY CHECK ALL SYSTEMS EVERY WEEK DURING MAINTENANCE OF LANDSCAPE.
- 4. ALL IRRIGATION FILTERS AT THE WYE STRAINER (AT THE BACKFLOW DEVICE) AND ALL FILTERS AT THE DRIP IRRIGATION VALVES TO BE CLEANED MONTHLY OR AS NEEDED.
- 5. CHECK RAIN SHUT OFF DEVICE AT THE BEGINNING OF THE RAINY SEASON AND RE-CALIBRATE AS NEEDED. MAKE SURE DEVICE IS CLEAN, FREE OF ANY DEBRIS, AND IN GOOD WORKING ORDER.
- 6. BACKFLOW DEVICE TO BE VISUALLY CHECKED ON A MONTHLY BASIS. TEST AND RE-CERTIFY ANNUALLY AS PER ALL CODES AND ORDINANCES.
- 7. SCHEDULE ALL SPRAY SYSTEMS TO RUN ONLY BETWEEN THE HOURS OF
- 8. ON A MONTHLY BASIS, FLUSH ALL DRIP SYSTEM LINES AND CHECK VALVE BOXES TO SEE THAT THEY DRAIN PROPERLY. CLEAN OUT ANY DEBRIS, MUD OR PLANT GROWTH ANNUALLY.
- 9. TWICE A YEAR CHECK ALL QUICK COUPLERS AND MAKE ALL REPAIRS AS NECESSARY. REPLACE PEA GRAVEL IN VALVE BOXES AS NEEDED.
- 10. COVER OR PROTECT ALL BACKFLOW DEVICES DURING FREEZING WEATHER.
- II. OWNER TO PROVIDE FOR A WATER AUDIT EVERY FIVE YEARS FROM

# WATER CONSERVATION STATEMENT

WATER CONSERVATION IS ACHIEVED IN THIS LANDSCAPE CONSTRUCTION DOCUMENT AS DESCRIBED BELOW,

- I. ALL PLANT MATERIALS SELECTED FOR THIS SITE ARE APPROPRIATE FOR THE GEOGRAPHICAL LOCATION AND LOCAL CLIMATE, AND THEIR ADAPTABILITY TO DROUGHT. DATA FROM WUCOLS III HAS BEEN USED FOR DETERMINING THE SPECIES' PLANT FACTOR FOR THE WATER USE CALCULATIONS.
- 2. PLANTS WITH SIMILAR WATER USE REQUIREMENTS ARE GROUPED TOGETHER.
- 3. THE MAJORITY OF LANDSCAPE AREAS ARE PLANTED WITH LOW WATER USE PLANTS, WITH THE BALANCE IN MODERATE WATER USE PLANTS. NO HIGH WATER USE PLANTS ARE USED.
- 4. IRRIGATION SECTIONS: HYDROZONES ARE SEPARATED BY CONSIDERING PLANT SPECIES FACTOR, PLANT DENSITY AND MICROCLIMATE. IF LOW WATER USE PLANTS ARE MIXED WITH MODERATE WATER USE PLANTS IN THE SAME HYDROZONE, THE MODERATE WATER USE FACTOR IS USED FOR WATER USE CALCULATIONS. SEE HYDROZONE EXHIBIT.
- 5. THE IRRIGATION SYSTEM UTILIZES A LOW-VOLUME DISTRIBUTION SYSTEM WITH A MASTER VALVE, FLOW SENSOR, CHECK VALVES, ET BASED AUTOMATIC CONTROLLERS WITH CYCLE PLUS SOAK AND WATER BUDGETING CAPABILITY, WEATHER STATION, AND RAIN SHUT-OFF.
- 6. THE USE OF TURF IS ELIMINATED. ALL TREE, SHRUB AND GROUNDCOVER AREAS WILL BE DRESSED WITH A 2" LAYER OF MULCH FOR MOISTURE RETENTION AND TO DISCOURAGE WEEDS.
- 7. THERE ARE NO SPECIAL LANDSCAPE AREAS IN THIS PROJECT.


IRRIGATION SCHEDULE - INITIAL-ESTABLISHMENT PERIOD

	TIMING CHART					MINUTES OF OPERATION PER CYCLE											
	VALVE		HYDRO-	NO. OF	CYCLES/									·	·		
STATION	SIZE	GPM	ZONE	DAYS	DAY	JAN.	FEB.	MAR.	APR.	MAY	JUN.	JUL.	AUG.	SEP.	OCT.	NOV.	DEC.
1	1"	12.0	BUBBLER	5	1	1	1	1	2	2	2	2	2	2	1	1	1
2	1"	10.9	DRIP	5	2	10	13	15	16	18	20	24	24	20	16	14	12
3	1"	6.2	DRIP	5	2	10	13	15	16	18	20	24	24	20	16	14	12
4	1"	13.0	BUBBLER	5	1	1	1	1	2	2	2	2	2	2	1	1	1
5	1"	5.6	DRIP	5	2	10	13	15	16	18	20	24	24	20	16	14	12
6	1"	12.7	DRIP	5	2	10	13	15	16	18	20	24	24	20	16	14	12
7	1"	5.1	DRIP	5	2	10	13	15	16	18	20	24	24	20	16	14	12
8	1"	9.9	DRIP	5	2	10	13	15	16	18	20	24	24	20	16	14	12
9	1"	10.2	DRIP	5	2	10	13	15	16	18	20	24	24	20	16	14	12
10	1"	11.2	DRIP	5	2	10	13	15	16	18	20	24	24	20	16	14	12
11	1"	10.6	DRIP	5	2	10	13	15	16	18	20	24	24	20	16	14	12
12	1"	11.8	DRIP	5	2	10	13	15	16	18	20	24	24	20	16	14	12


## IRRIGATION SCHEDULE - POST-ESTABLISHMENT PERIOD

	• • •	<u> </u>			<b>O</b> • • •												
TIMING CHART			MINUTES OF OPERATION PER CYCLE														
	VALVE		HYDRO-	NO. OF	CYCLES/												
STATION	SIZE	GPM	ZONE	DAYS	DAY	JAN.	FEB.	MAR.	APR.	MAY	JUN.	JUL.	AUG.	SEP.	OCT.	NOV.	DEC.
ĺ	1"	12.0	BUBBLER	5	1	1	1	1	2	2	2	2	2	2	1	1	1
2	1"	10.9	DRIP	5	1	10	13	15	16	18	20	24	24	20	16	14	12
3	1"	6.2	DRIP	5	1	10	13	15	16	18	20	24	24	20	16	14	12
4	1"	13.0	BUBBLER	5	1	1	1	1	2	2	2	2	2	2	1	1	1
5	1"	5.6	DRIP	5	1	10	13	15	16	18	20	24	24	20	16	14	12
6	1"	12.7	DRIP	5	1	10	13	15	16	18	20	24	24	20	16	14	12
7	1"	5.1	DRIP	5	1	10	13	15	16	18	20	24	24	20	16	14	12
8	1"	9.9	DRIP	5	1	10	13	15	16	18	20	24	24	20	16	14	12
9	1"	10.2	DRIP	5	1	10	13	15	16	18	20	24	24	20	16	14	12
10	1"	11.2	DRIP	5	1	10	13	15	16	18	20	24	24	20	16	14	12
11	1"	10.6	DRIP	5	1	10	13	15	16	18	20	24	24	20	16	14	12
12	1"	11.8	DRIP	5	1	10	13	15	16	18	20	24	24	20	16	14	12

IRRIGATION SCHEDULES ARE A GUIDELINE ONLY AND DO NOT PROVIDE FOR CHANGING WEATHER CONDITIONS, ETC. CONTRACTOR MAY NEED TO MAKE SLIGHT ADJUSTMENTS IN THE FIELD TO MAINTAIN COVERAGE AND MOISTURE CONTENT IN THE SOIL FOR PROPER AND REQUIRED PLANT GROWTH.

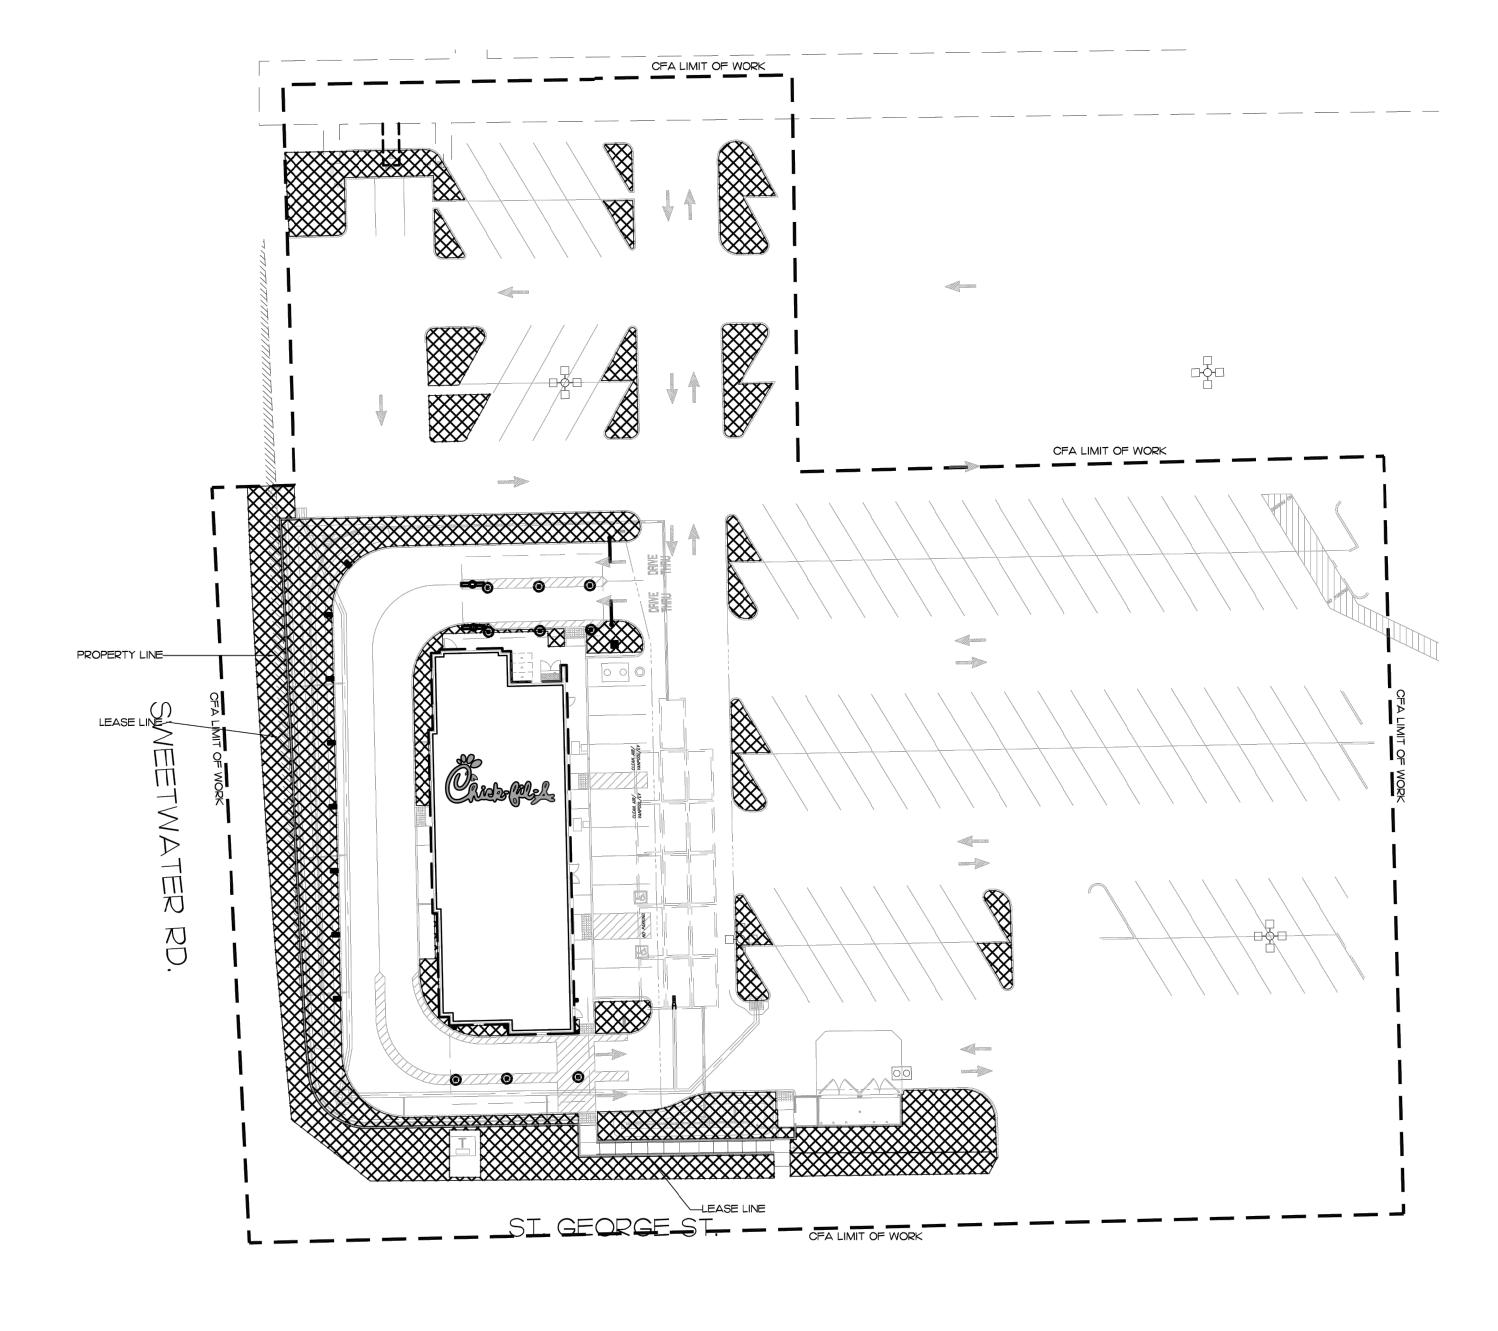



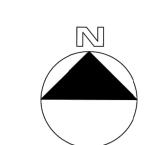

HYDROZONE MAP LEGEND LOW/MOD WATER USING PLANTS 12,908 S.F.

PROJECT ADDRESS:

5845111600

5845111800

5845111900

(858) 271-4682

2900 FOURTH AVENUE #204


619-233-6450 WWW.ZAAP.BIZ

SAN DIEGO, CA 92103

PREPARED BY

ZAAP, INC.

5845112000

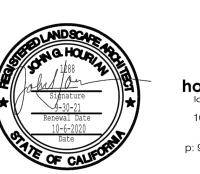





935 SWEETWATER ROAD COMMUNITY PLAN: SPRING VALLEY GENERAL PLAN REGIONAL CATEGORY: VILLAGE VILLAGE BOUNDARY: SPRING VALLEY ZONING: C36


> PROJECT NAME: SHOPPING CENTER -SPRING VALLEY


SHEET TITLE: LANDSCAPE CONCEPT PLAN



S.E.C. JAMACHA RD. & SWEETWATER RD. SPRING VALLEY, CA

Spring Valley, CA 91977 PROJECT NO: 16350 ASSESSOR'S PARCEL 5845111700 (NOT A PART) REVISION #: DATE: REVISION #: DATE:

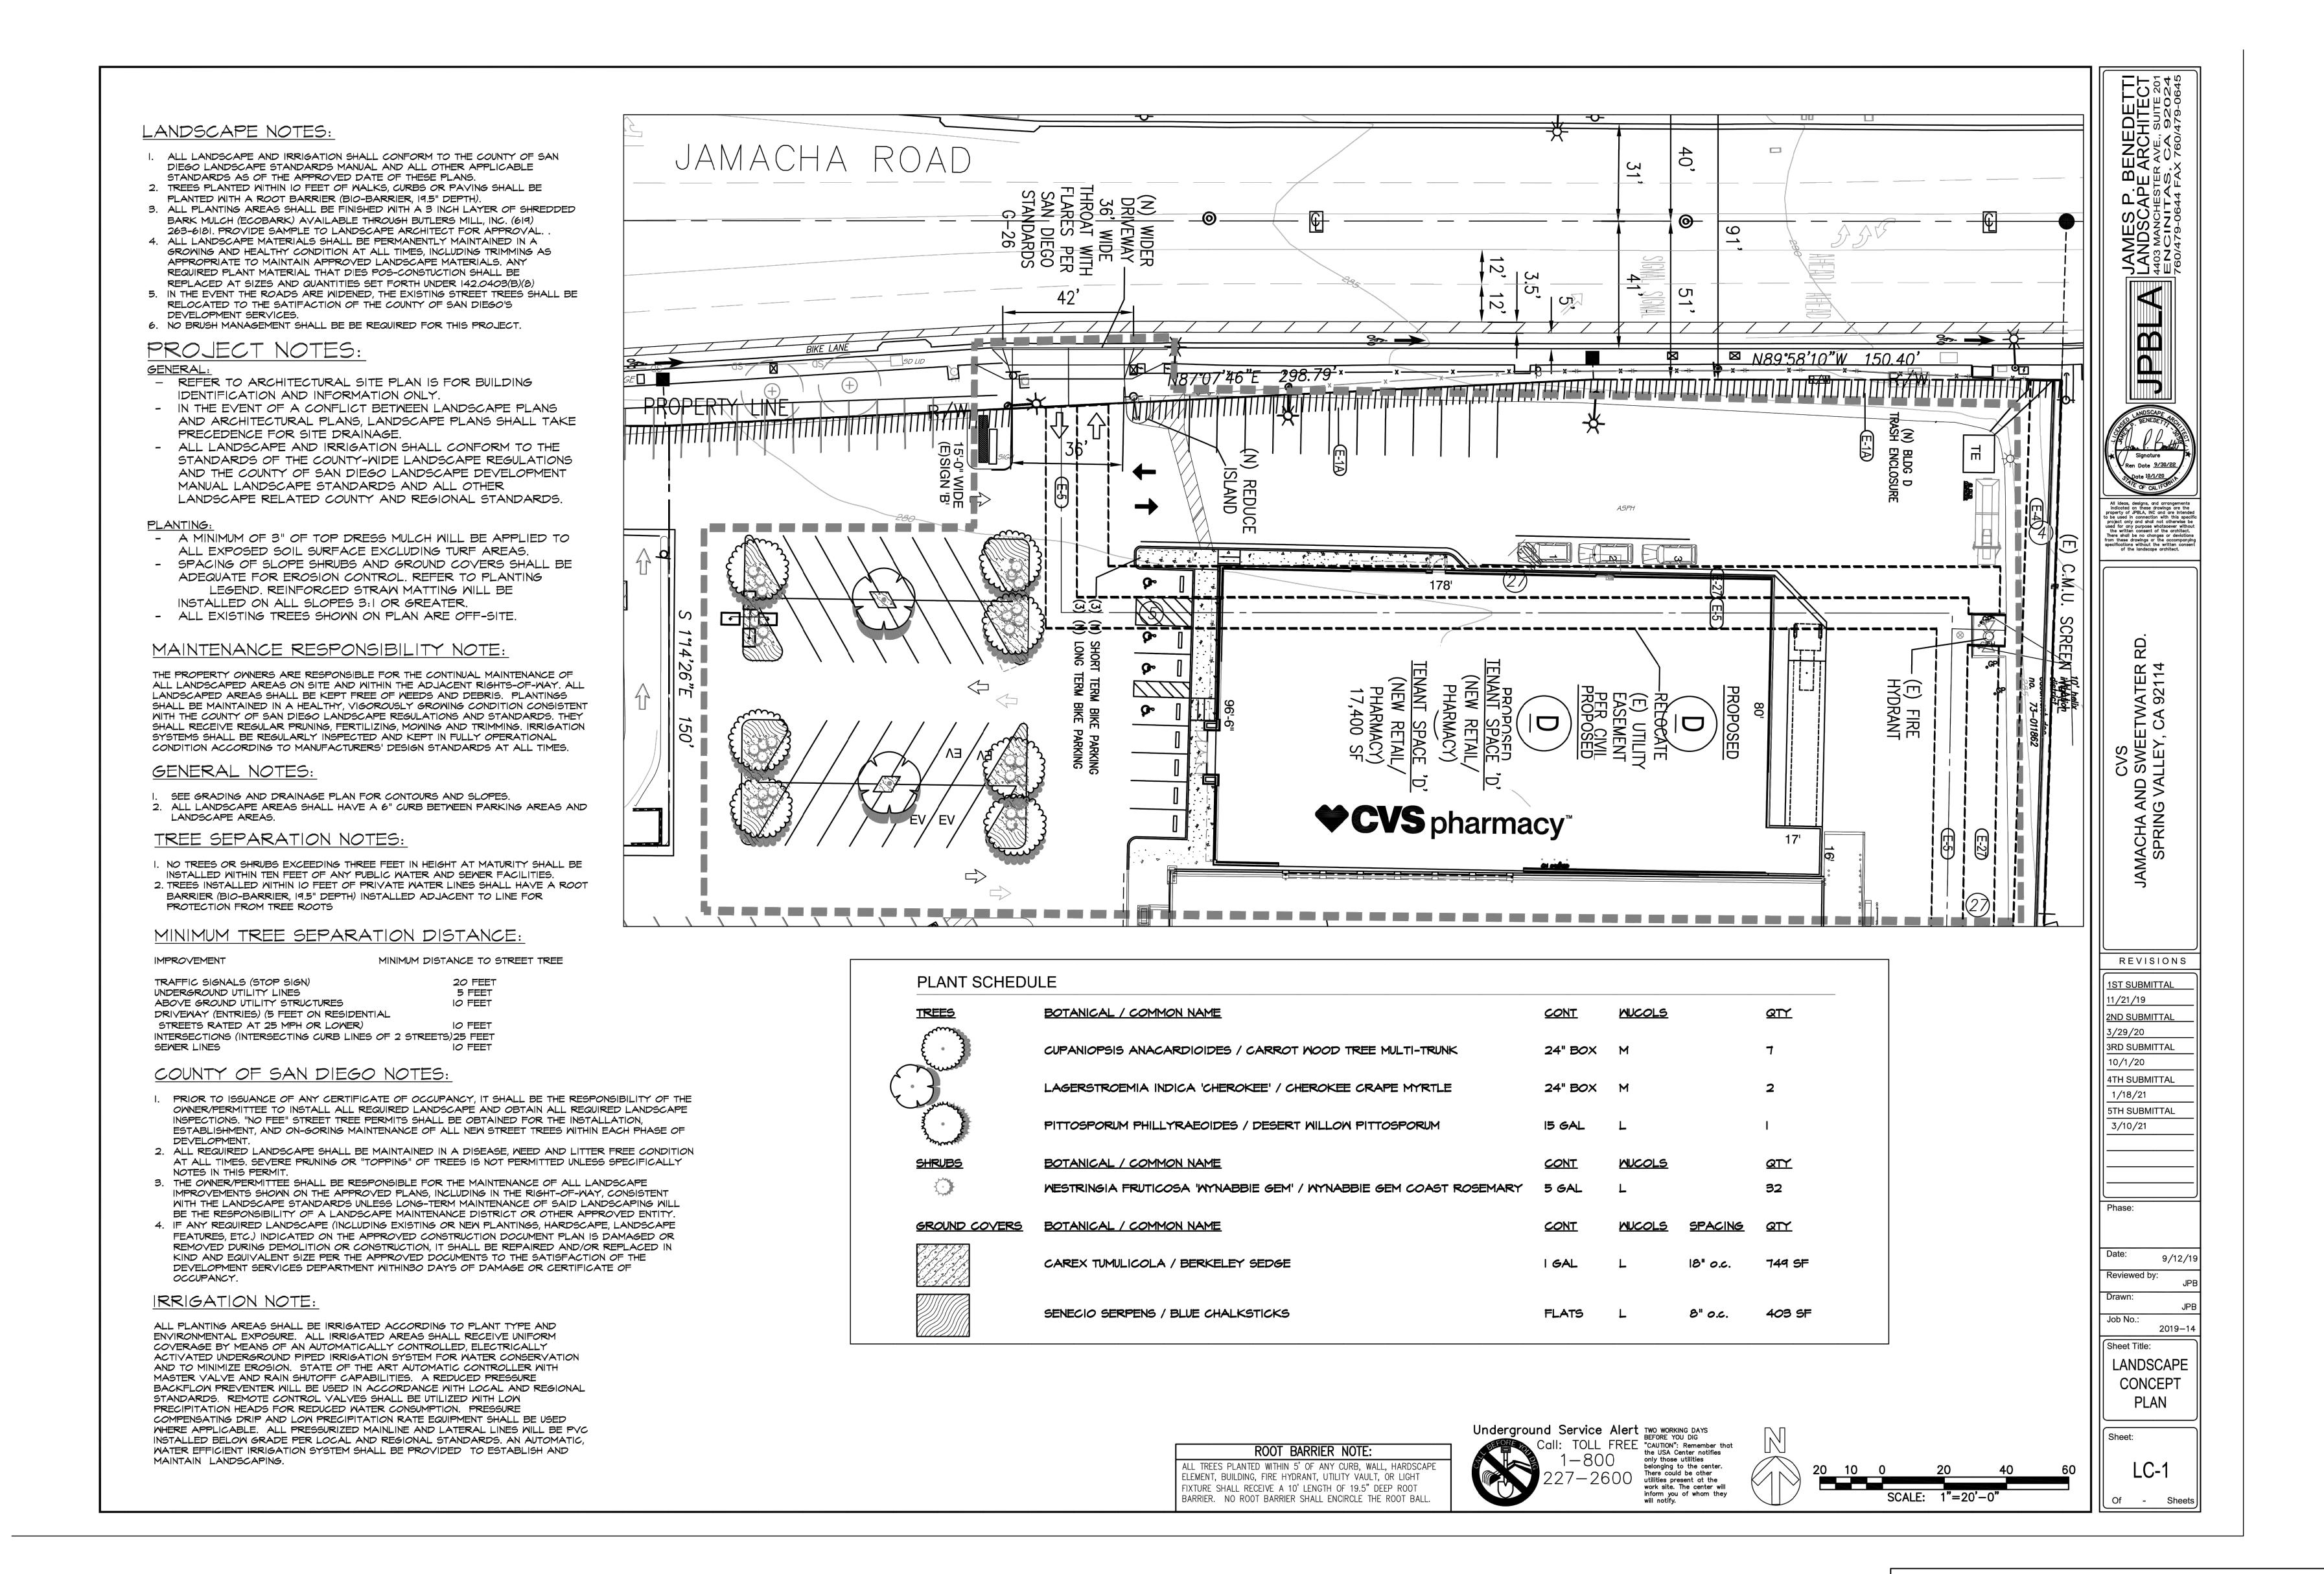

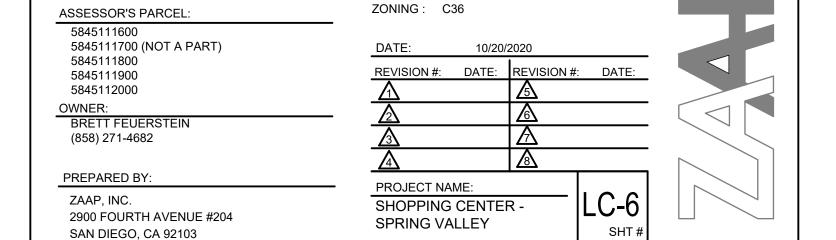

COMMUNITY PLAN: SPRING VALLEY

VILLAGE BOUNDARY: SPRING VALLEY

GENERAL PLAN REGIONAL CATEGORY: VILLAGE

SHEET TITLE: LANDSCAPE CONCEPT PLAN


PROJECT ADDRESS:

935 SWEETWATER ROAD

619-233-6450 WWW.ZAAP.BIZ

Spring Valley, CA 91977

PROJECT NO: 16350

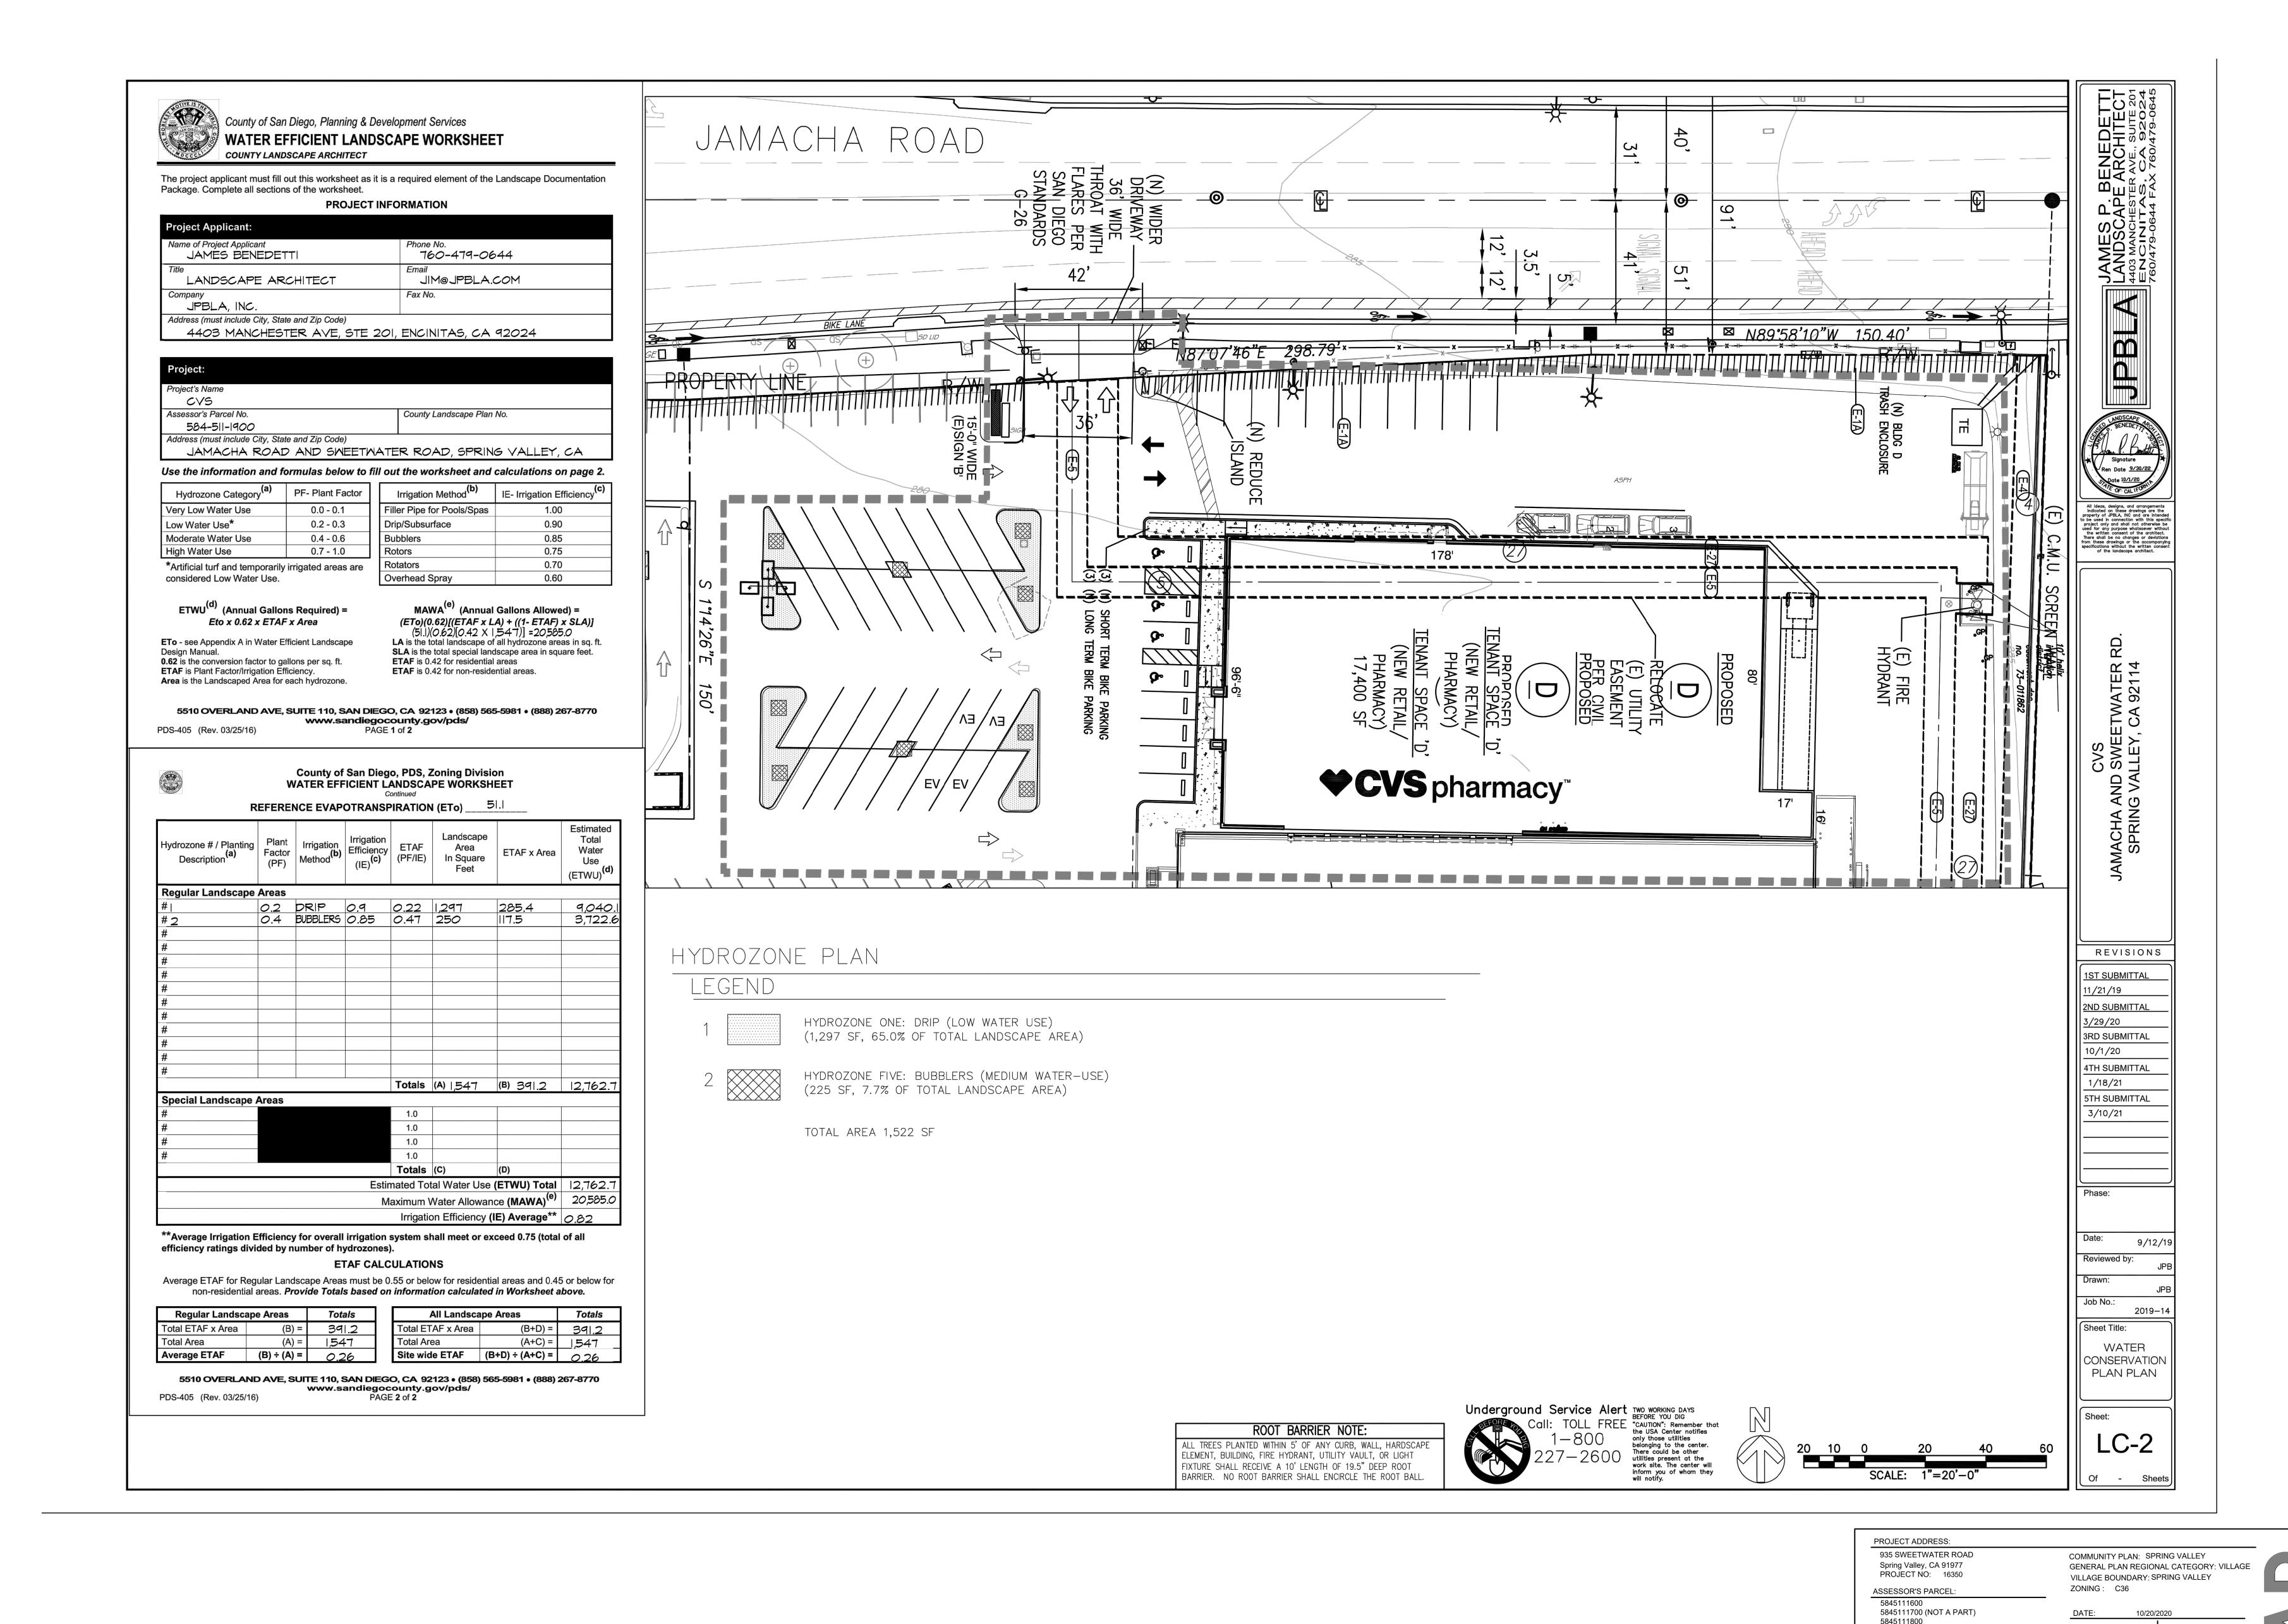

REVISION #: DATE: REVISION #: DATE:

SHEET TITLE: LANDSCAPE CONCEPT PLAN

PROJECT NAME:

SHOPPING CENTER -

SPRING VALLEY

5845112000

(858) 271-4682

2900 FOURTH AVENUE #204

SAN DIEGO, CA 92103 619-233-6450 WWW.ZAAP.BIZ

PREPARED BY

ZAAP, INC.

